

ARCHITECTURE

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 PH · 269.327.0077 EM · INFO@TMP-ARCHITECTURE.COM

# ROOFING RENOVATIONS BATTLE CREEK PUBLIC SCHOOLS

BATTLE CREEK, MI 49017  
 PROJECT NUMBER 25041  
 CONSTRUCTION DOCUMENTS

**CONSULTANTS:**  
 ELECTRICAL ENGINEER  
**IGNYTE DESIGN**  
 ELECTRICAL ENGINEERS  
 123 DEVISSER PLACE  
 KALAMAZOO, MI 49007  
 PHONE: (269) 207-9247

**LIST OF PROJECTS**  
**ANN J KELLOGG ROOFING RENO.**  
**25041B**  
 TS.1 COVER SHEET  
 TG.1 GENERAL INFORMATION  
 A1.3 COMPOSITE ROOF PLAN  
 A4.1 WALL SECTIONS

**FREMONT ACADEMY ROOFING RENO.**  
**25041J**  
 TS.1 COVER SHEET  
 TG.1 GENERAL INFORMATION  
 A1.3 COMPOSITE ROOF PLAN

**URBANDALE ELEM. ROOFING RENO.**  
**25041T**  
 TS.1 COVER SHEET  
 TG.1 GENERAL INFORMATION  
 A1.3 COMPOSITE ROOF PLAN

**W.K. KELLOGG ROOFING RENO.**  
**25041W**  
 TS.1 COVER SHEET  
 TG.1 GENERAL INFORMATION  
 A1.3 COMPOSITE ROOF PLAN  
 A4.1 WALL SECTIONS

**CODE:** .....

**GOVERNING CODES:**  
 - 2016 SCHOOL FIRE SAFETY RULES  
 - (2012 Life Safety Code, plus amendments)  
 - 2021 MICHIGAN BUILDING CODE  
 - 2021 MICHIGAN REHABILITATION CODE FOR EXISTING BUILDINGS  
 - 2021 MICHIGAN PLUMBING CODE  
 - 2021 MICHIGAN MECHANICAL CODE  
 - 2021 MICHIGAN COMMERCIAL ENERGY CODE  
 (ANSI/ASHRAE/IES Standard 90.1-2019)  
 - 2023 MICHIGAN ELECTRICAL CODE (2023 NEC, plus Part 8 Rules)  
 - 2023 MICHIGAN ELEVATOR RULES  
 (ASME A17.1-2016, ASME A18.1-2017)  
 - MICHIGAN BARRIER FREE CODE  
 (Michigan Building Code 2021 and ICC A117.1-2017)  
 - 2019 MICHIGAN BOILER CODE RULES  
 (ASME Boiler and Pressure Vessel Code, 2019 edition)  
 (National Board Inspection Code [NBIC], 2019 edition)  
 CONSTRUCTION CLASSIFICATION : TYPE II (000)  
 LSC TYPE II-B (MBC)  
 USE GROUP CLASSIFICATION : "E" EDUCATION


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**PROJECT TITLE**  
**Roofing Renovations**  
**PROJECT NO.**  
**25041**  
**DRAWING NO.**  
**TS.1**

01-12-2026 CONSTRUCTION DOCUMENTS  
**DATE ISSUED FOR:**



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# ANN J KELLOGG ROOFING RENOVATIONS BATTLE CREEK PULBIC SCHOOLS

## BATTLE CREEK, MI 49017 PROJECT NUMBER 25041B CONSTRUCTION DOCUMENTS

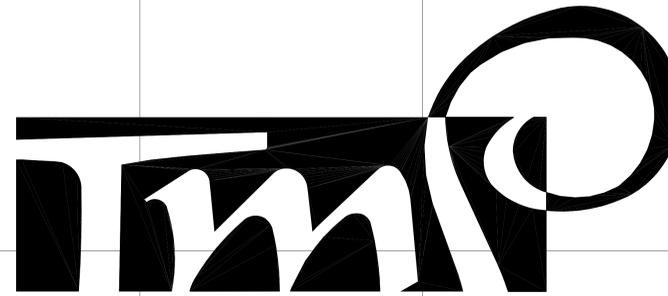**CONSULTANTS:**

**LIST OF DRAWINGS**

**GENERAL INFORMATION**  
TS.1 COVER SHEET  
TG.1 GENERAL INFORMATION

**ARCHITECTURAL**  
A1.3 COMPOSITE ROOF PLAN  
A4.1 WALL SECTIONS

**PROJECT DATA:**

**LOCATION MAP**



BATTLE CREEK, MI. NO SCALE

**BUILDING:**

BUILDING AREA(S) = 000,000 SQ. FT. (ADDITION)  
102,417 SQ. FT. (EXISTING)  
102,417 SQ. FT. (TOTAL)  
58,946 SQ. FT. (ROOFING REPLACEMENT)

**CODE:**

**GOVERNING CODES:**  
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(2012 Life Safety Code, plus amendments)  
- 2021 MICHIGAN BUILDING CODE  
- 2021 MICHIGAN REHABILITATION CODE FOR EXISTING BUILDINGS  
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(ASME Boiler and Pressure Vessel Code, 2019 edition)  
(National Board Inspection Code [NBIC], 2019 edition)  
**CONSTRUCTION CLASSIFICATION : TYPE II (000)**  
LSC TYPE II-B (MBC)  
**USE GROUP CLASSIFICATION : "E" EDUCATION**

**ADDRESS:** BATTLE CREEK PUBLIC SCHOOLS  
306 CHAMPION STREET  
BATTLE CREEK, MI 49037

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**PROJECT TITLE**  
**Ann J Kellogg Roofing Reno.**  
**PROJECT NO.**  
**25041B**  
**DRAWING NO.**  
**TS.1**

01-12-2026 CONSTRUCTION DOCUMENTS  
**DATE ISSUED FOR:**





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 KALAMAZOO - MICHIGAN - 49007  
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REGISTRATION SEAL

CONSULTANT

PROJECT TITLE  
**Ann J Kellogg  
 Roofing  
 Renovations**

**Battle Creek Public Schools  
 Battle Creek, Michigan**

DRAWING TITLE  
**Composite Roof Plan**

ISSUE DATES

01-12-2026 CONSTRUCTION DOCUMENTS

DATE ISSUED FOR:

DRAWN TH

CHECKED EW

APPROVED FG

PROJECT NO.

**25041B**

DRAWING NO.

**A1.3**

ROOF PLAN LEGEND	
	EXISTING ROOF DRAIN
	EXISTING VENT STACK, EXHAUST, MECHANICAL PENETRATION. SEE GENERAL ROOF NOTE 3.
	NEW ROOFTOP MECHANICAL EQUIPMENT IN EXISTING ROOF AREA. SEE GENERAL ROOF NOTE 3.
	INDICATES PITCH OF ROOF STRUCTURE


- GENERAL NOTES**
- INFORMATION FOR EXISTING CONDITIONS TAKEN FROM OWNER PROVIDED DOCUMENTS AND VISUAL INSPECTIONS OF THE BUILDING. CONTRACTOR SHALL VERIFY ALL EXISTING CONDITIONS IN THE FIELD PRIOR TO INSTALLATION OF NEW WORK AND REPORT ALL DISCREPANCIES TO THE ARCHITECT AND CONSTRUCTION MANAGER.
  - CONTRACTOR SHALL BE RESPONSIBLE FOR THE PROTECTION OF ALL EXISTING UTILITIES ON OR NEAR THE PROJECT ROOF DURING THE WORK. PROVIDE PROPER SAFETY MEASURES NEAR ELECTRICAL SERVICE LINES.
  - ROOF PENETRATIONS AND THEIR LOCATIONS ARE APPROXIMATE. CONTRACTOR SHALL BE RESPONSIBLE FOR PROPER FLASHING OF ALL EXISTING DRAINS, CURBS, VENT STACKS, ETC., AFFECTED WITHIN THE PROJECT SCOPE.
  - CONTRACTOR SHALL BE RESPONSIBLE FOR VERIFYING FIELD SEAM LOCATIONS AND DIRECTIONS IN THE FIELD.
  - ALL EXISTING TAPER INSULATION LAYOUTS AND SADDLES ARE NOT SHOWN.
  - CAUTION: EXISTING ELECTRICAL CONDUITS, LIGHTS, PLUMBING PIPING OR MECHANICAL LINES MAY BE ATTACHED TO OR NEAR THE UNDERSIDE OF THE ROOF DECK. CONTRACTOR SHALL BE RESPONSIBLE FOR INVESTIGATING CONDITIONS BELOW DECKS TO AVOID DAMAGING EXISTING SYSTEMS.
  - CONTRACTOR SHALL DISCONNECT AND RECONNECT EQUIPMENT AS REQUIRED TO COMPLETE ROOF REPAIRS AND REPLACEMENTS. EMPLOY MECHANICAL OR ELECTRICAL SUBCONTRACTORS AS NEEDED. COORDINATE THIS WORK WITH THE CONSTRUCTION MANAGER AND OWNER.
  - PROTECT EXISTING ROOF MEMBRANES TO REMAIN FROM DAMAGE AND PUNCTURES FROM ALL ROOF TRAFFIC AND OPERATIONS UNDER THIS CONTRACT. RESTORE OR REPLACE ANY DAMAGED AREAS.
  - EXISTING LIGHTS, LADDERS, ANTENNA, GUTTERS, DOWNSPOUTS, MECHANICAL UNITS, VENT STACKS & OTHER ROOF TOP EQUIPMENT & PENETRATIONS ARE TO REMAIN UNLESS SPECIFICALLY CALLED OUT OTHERWISE.
  - WHERE WOOD NAILERS ARE SHOWN IN PLANE OF ROOF INSULATION, CUT NAILERS AS REQUIRED TO MATCH INSULATION THICKNESS.
  - TAPERED INSULATION SADDLES/ CRICKETS SHALL BE 1/2" PER FOOT MIN.
  - PROVIDE ROOF WALKWAYS FROM ROOF HATCHES / LADDERS TO ALL ROOF TOP EQUIPMENT AND PENTHOUSE DOORWAYS.

- REPLACEMENT WORK KEY NOTES: BASE BID**
- A EXISTING SYSTEM:**  
 EXISTING ROOF CONSISTS OF BUILT UP ROOF SYSTEM WITH GRAVEL BALLAST AND GRAVEL STOP.  
**REPLACEMENT SCOPE:**  
 REMOVE AND DISPOSE OF EXISTING BALLAST AND GRAVEL STOP. SLICE EXISTING MEMBRANE ON 10'-0" GRID (MAX.), LEAVING IN PLACE. OVERLAY WITH FULLY ADHERED SINGLE PLY 60 MIL TPO ROOFING MEMBRANE ON FULLY ADHERED 1/2" POLYSTYRO COVER BOARD WITH NEW GRAVEL STOP.
- B EXISTING SYSTEM:**  
 EXISTING ROOF CONSISTS OF SINGLE PLY TPO ON 2 PLY FIBERGLASS ON 1/2" FIBERBOARD ON 3-1/2" POLYSTY. INSULATION ON CONCRETE DECK.  
**REPLACEMENT SCOPE:**  
 REMOVE AND DISPOSE OF EXISTING FLASHING AND TERMINATION BAR. REMOVE AND DISPOSE OF EXISTING MEMBRANE FROM PARAPET WALL AS REQUIRED FOR INSTALLATION OF NEW WORK. SLICE EXISTING MEMBRANE ON 10'-0" GRID (MAX.), LEAVING IN PLACE. OVERLAY WITH FULLY ADHERED SINGLE PLY 60 MIL TPO ROOFING MEMBRANE ON FULLY ADHERED 1/2" POLYSTYRO COVER BOARD.
- C EXISTING SYSTEM:**  
 EXISTING ROOF CONSISTS OF BUILT UP ROOF SYSTEM WITH GRAVEL BALLAST, 1 PCE FLASHING, AND TERMINATION BAR.  
**REPLACEMENT SCOPE:**  
 REMOVE AND DISPOSE OF EXISTING BALLAST, TERMINATION BAR, AND 1 PCE FLASHING. SLICE EXISTING MEMBRANE ON 10'-0" GRID (MAX.), LEAVING IN PLACE. OVERLAY WITH FULLY ADHERED SINGLE PLY 60 MIL TPO ROOFING MEMBRANE ON FULLY ADHERED 1/2" POLYSTYRO COVER BOARD.
- D EXISTING SYSTEM:**  
 EXISTING ROOF CONSISTS OF BUILT UP ROOF SYSTEM WITH GRAVEL BALLAST AND METAL COPING.  
**REPLACEMENT SCOPE:**  
 REMOVE AND DISPOSE OF EXISTING BALLAST FROM BUILT UP ROOF. REMOVE AND SALVAGE FOR REUTILIZATION EXISTING METAL COPING. REMOVE AND DISPOSE OF EXISTING MEMBRANE FROM PARAPET WALL AS REQUIRED FOR INSTALLATION OF NEW WORK. SLICE EXISTING MEMBRANE ON 10'-0" GRID (MAX.), LEAVING IN PLACE. OVERLAY WITH FULLY ADHERED SINGLE PLY 60 MIL TPO ROOFING MEMBRANE ON FULLY ADHERED 1/2" POLYSTYRO COVER BOARD.
- E EXISTING SYSTEM:**  
 EXISTING ROOF CONSISTS OF ASPHALT SHINGLES ON UNDERLAYMENT ON PLYWOOD DECK.  
**REPLACEMENT SCOPE:**  
 REMOVE AND DISPOSE OF EXISTING ASPHALT SHINGLES AND UNDERLAYMENT DOWN TO EXISTING PLYWOOD DECK. REPLACE ANY DAMAGED OR SATURATED PLYWOOD. PROVIDE NEW ASPHALT SHINGLE ROOFING WITH CONTINUOUS ICE AND WATER SHIELD AND FLASHING.
- F EXISTING SYSTEM:**  
 EXISTING ROOF CONSISTS FLUID APPLIED RESTORATION SYSTEM ON 1 LAYER 1 PLY POLYESTER AND 1 LAYER 1 PLY EPDM WITH GRAVEL STOP.  
**REPLACEMENT SCOPE:**  
 REMOVE AND DISPOSE OF EXISTING SINGLE PLY ROOFING MEMBRANES AND INSULATION DOWN TO WOOD DECK. PROVIDE NEW FULLY ADHERED SINGLE PLY 60 MIL TPO ROOFING MEMBRANE ON FULLY ADHERED 1/2" POLYSTYRO COVER BOARD ON R-30 MIN INSULATION.
- G EXISTING SYSTEM:**  
 EXISTING ROOF CONSISTS FLUID APPLIED RESTORATION SYSTEM ON BUILT UP ROOF SYSTEM.  
**REPLACEMENT SCOPE:**  
 SLICE EXISTING MEMBRANE ON 10'-0" GRID (MAX.), LEAVING IN PLACE. OVERLAY WITH FULLY ADHERED SINGLE PLY 60 MIL TPO ROOFING MEMBRANE ON FULLY ADHERED 1/2" POLYSTYRO COVER BOARD.


**ALTERNATE SCOPE**

ALTERNATE NO. 1:  
 IN ALL AREAS OF NEW WORK ABOVE, USE FULLY ADHERED KEE ROOFING MEMBRANE ON 1/2" POLYSTYRO COVER BOARD IN LIEU OF FULLY ADHERED TPO ROOFING MEMBRANE ON 1/2" POLYSTYRO COVER BOARD.

- SPECIAL NOTES**
- EXISTING CONDITIONS ASSUMED BASED ON EXISTING DRAWINGS FROM THE 1950s AND 1978, ROOFING REPORTS FROM 2023, AND FIELD OBSERVATION. CONTRACTOR TO PROVIDE SITE CONFERENCE AFTER DEMOLITION WITH ARCHITECT TO CONFIRM EXISTING CONDITIONS.
  - CONTRACTOR TO PROVIDE FULL THERMAL SCAN OF ROOF. PROVIDE REPORT TO OWNER AND ARCHITECT TO DETERMINE FULL SCOPE OF INSULATION SATURATION AND CONDITION OF EXISTING ROOF DECK.

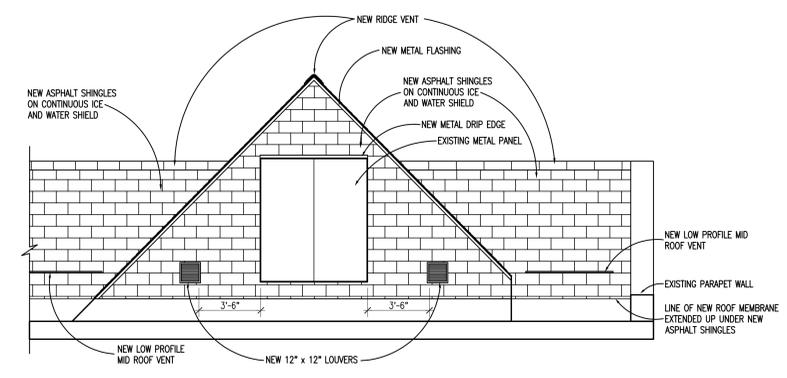

**1 SHINGLED GABLE END ELEVATION**  
 SCALE: 1/4" = 1'-0"

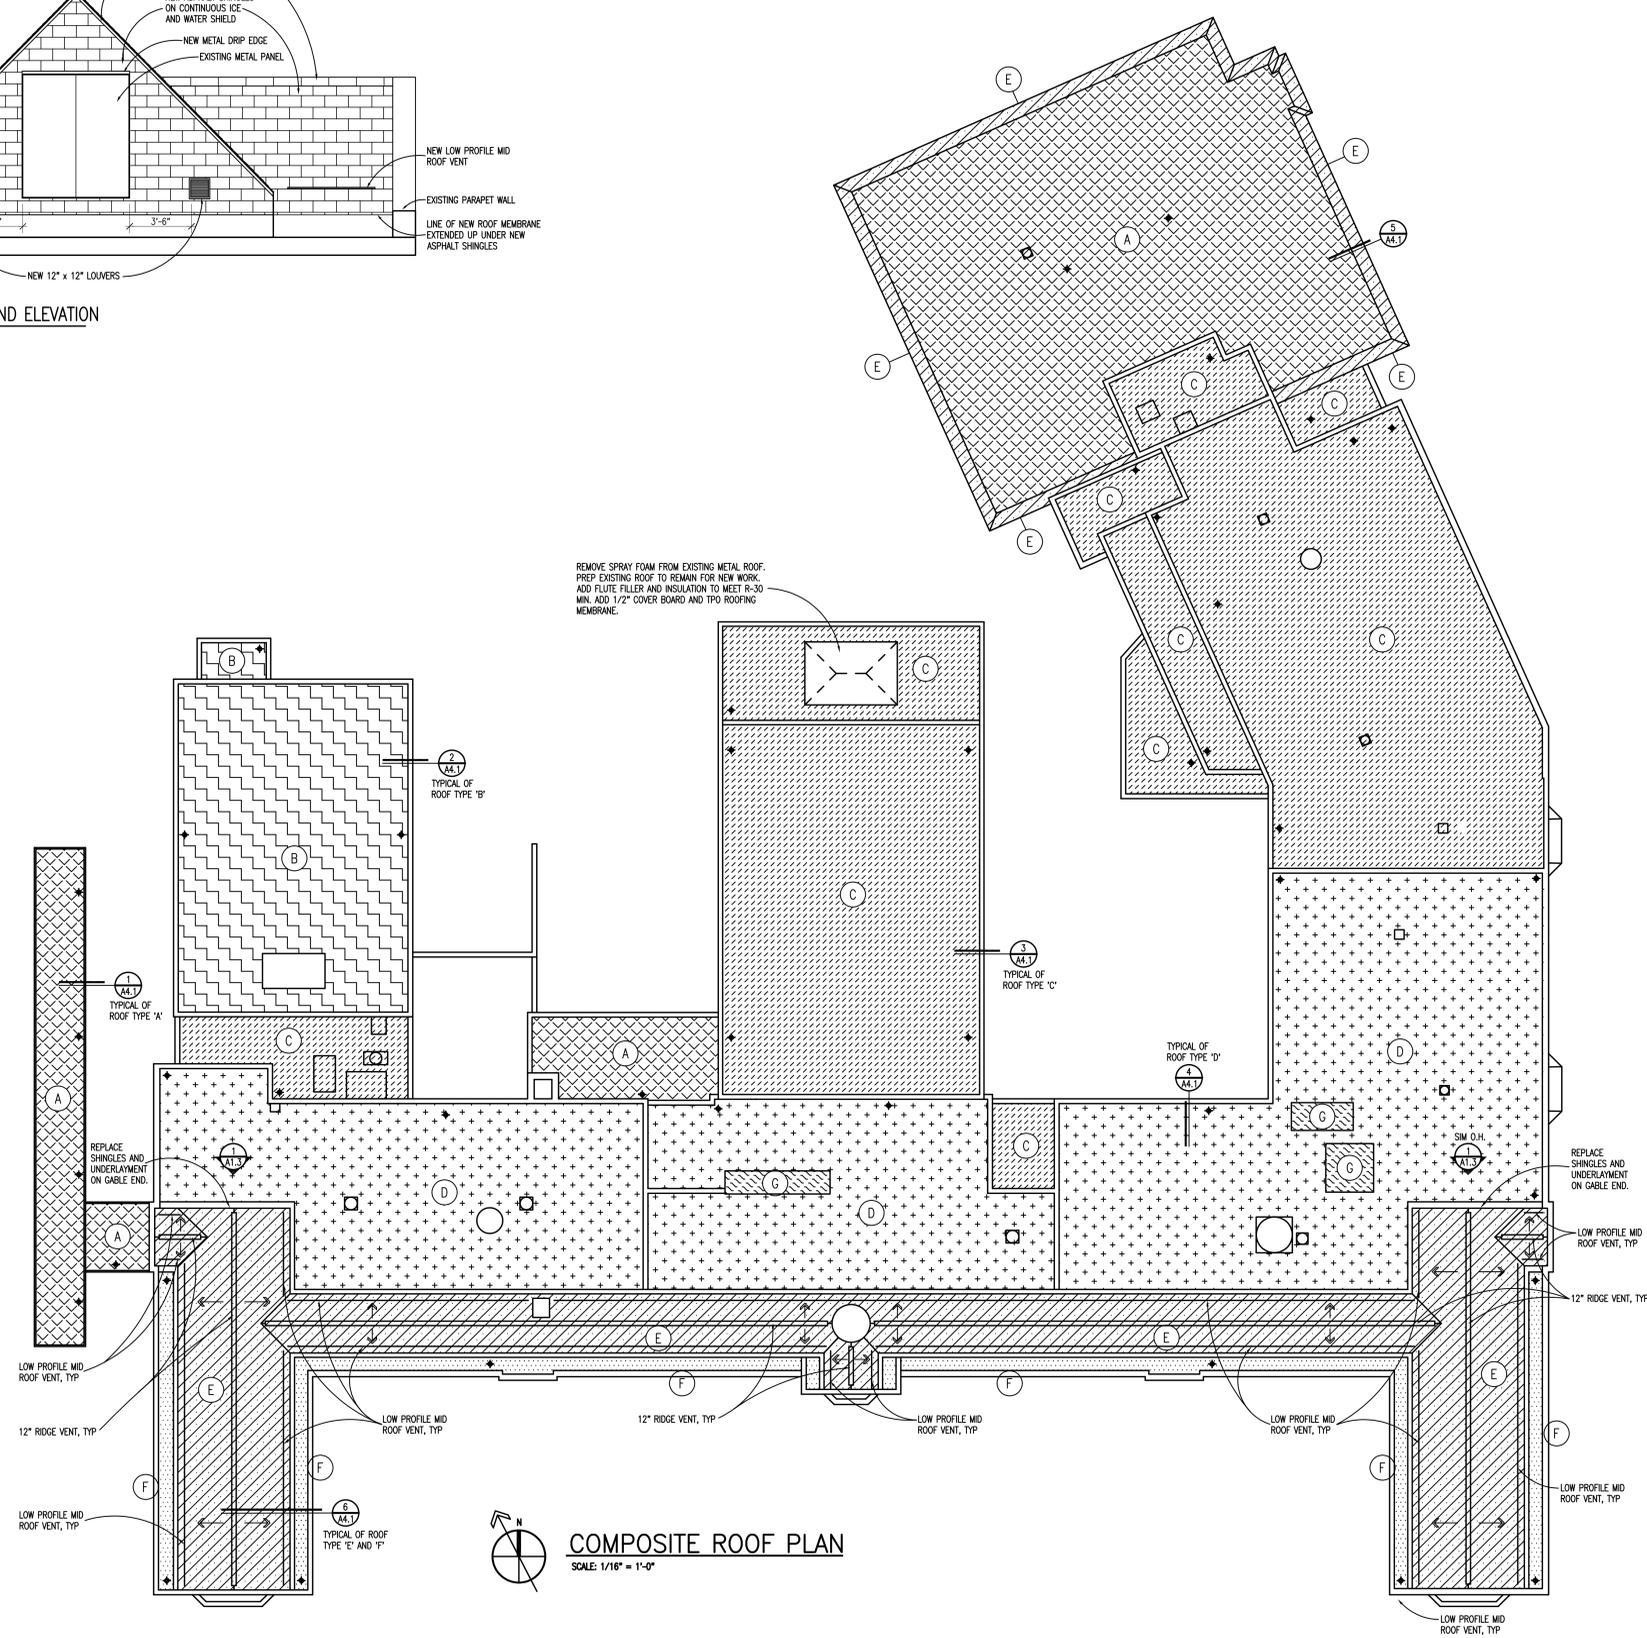

**COMPOSITE ROOF PLAN**  
 SCALE: 1/16" = 1'-0"

Drawing File: \\saw02\proj\25041B\25041B\_A1.3\_CompRoof\_Plan.rvt  
 Date: 01-12-2026 10:25:00 AM  
 User: jgibson

REGISTRATION SEAL

CONSULTANT

PROJECT TITLE  
**Ann J Kellogg  
 Roofing  
 Renovations**

**Battle Creek Public Schools  
 Battle Creek, Michigan**

DRAWING TITLE  
**Wall Section Details**

ISSUE DATES

01-12-2026 CONSTRUCTION DOCUMENTS

DATE: ISSUED FOR:

DRAWN TH

CHECKED EW

APPROVED FG

PROJECT NO.


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DRAWING NO.


**A4.1**

**SPECIAL NOTES**


- EXISTING CONDITIONS ASSUMED BASED ON EXISTING DRAWINGS FROM THE 1950s AND 1976. ROOFING REPORTS FROM 2023, AND FIELD OBSERVATION. CONTRACTOR TO PROVIDE SITE CONFERENCE AFTER DEMOLITION WITH ARCHITECT TO CONFIRM EXISTING CONDITIONS.
- CONTRACTOR TO PROVIDE FULL THERMAL SCAN OF ROOF. PROVIDE REPORT TO OWNER AND ARCHITECT TO DETERMINE FULL SCOPE OF INSULATION SATURATION AND CONDITION OF EXISTING ROOF DECK.

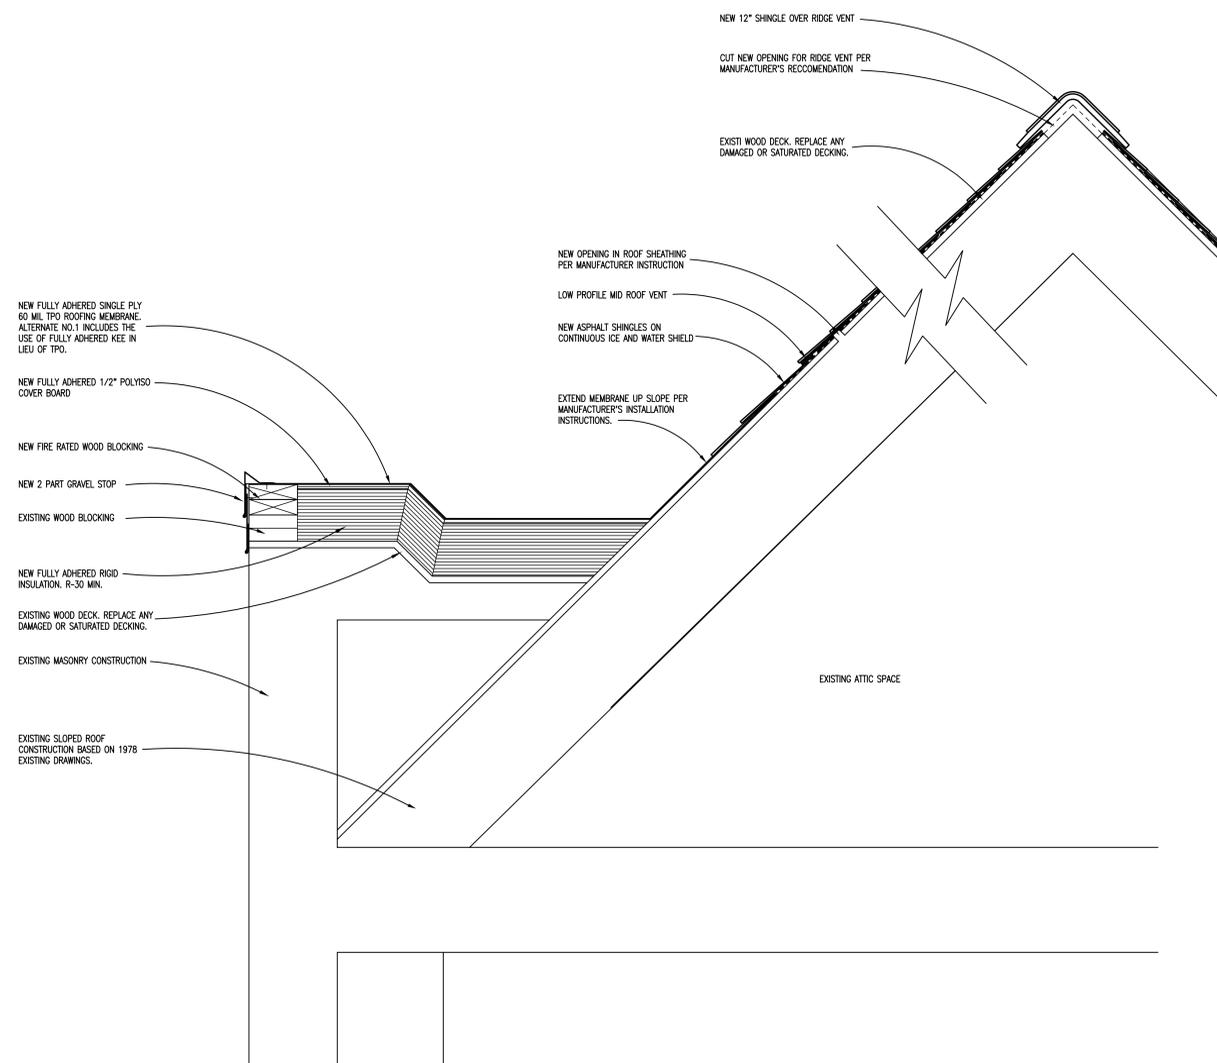


**6** DETAIL AT NORTH SHINGLE TO MEMBRANE TRANSITION  
 SCALE: 1 1/2" = 1'-0"

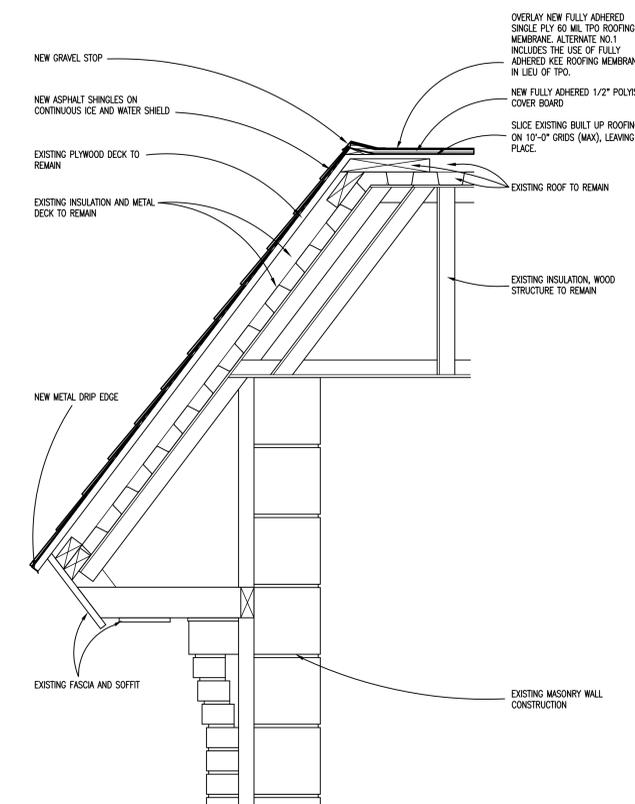


**5** DETAIL AT NORTH SHINGLE ROOF  
 SCALE: 1 1/2" = 1'-0"

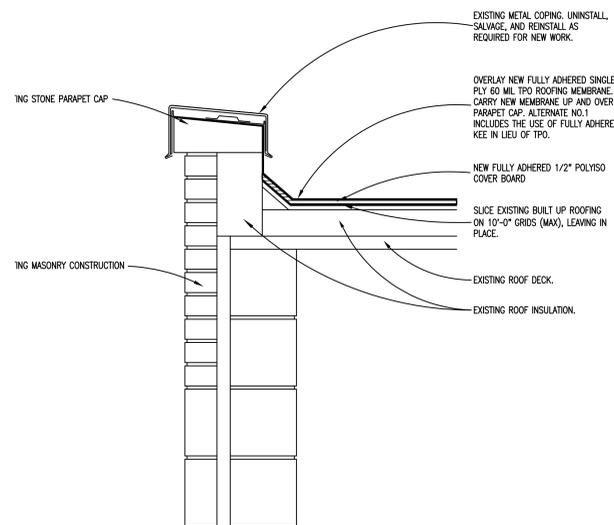


**4** TYP. DETAIL AT EX. TPA ROOFING  
 SCALE: 1 1/2" = 1'-0"

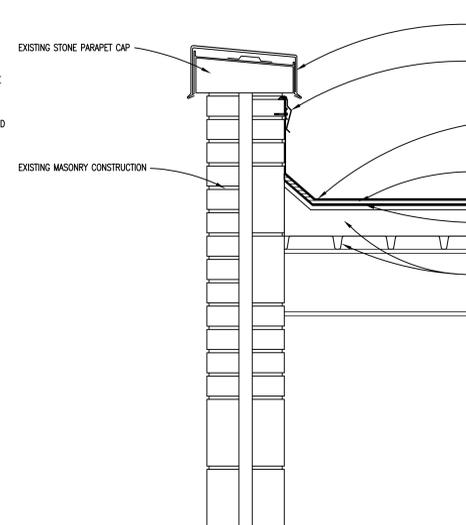

**3** TYP. DETAIL AT EX. TPA ROOFING  
 SCALE: 1 1/2" = 1'-0"

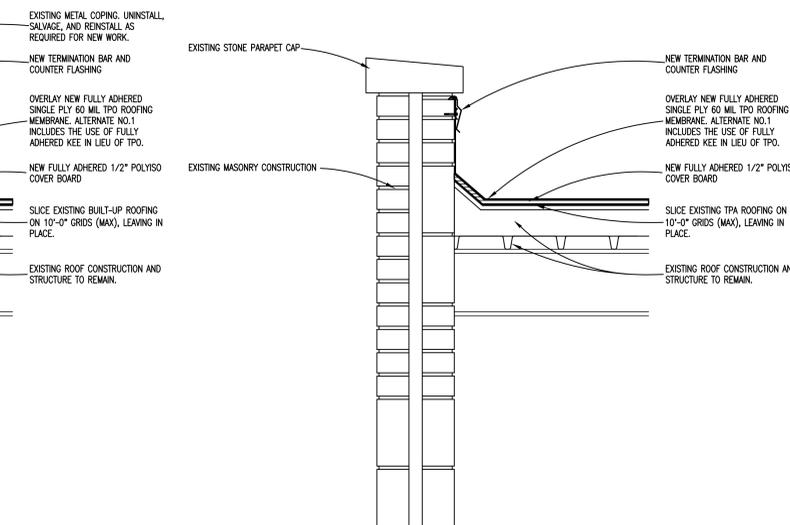

**2** TYP. DETAIL AT EX. TPA ROOFING  
 SCALE: 1 1/2" = 1'-0"

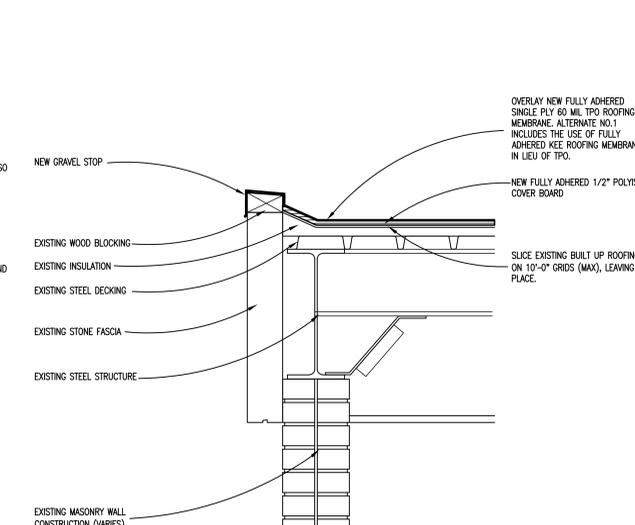

**1** TYP. DETAIL AT GRAVEL STOP  
 SCALE: 1 1/2" = 1'-0"



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 PH · 269.327.0077 EM · INFO @ TMP-ARCHITECTURE.COM

# FREMONT ACADEMY ROOFING RENOVATIONS

## BATTLE CREEK PULBIC SCHOOLS

BATTLE CREEK, MI 49017  
 PROJECT NUMBER 25041J  
 CONSTRUCTION DOCUMENTS


**LIST OF DRAWINGS**

**GENERAL INFORMATION** .....  
 TS.1 COVER SHEET  
 TG.1 GENERAL INFORMATION

**ARCHITECTURAL** .....  
 A1.3 COMPOSITE ROOF PLANS AND DETAILS

**PROJECT DATA:**

**LOCATION MAP**

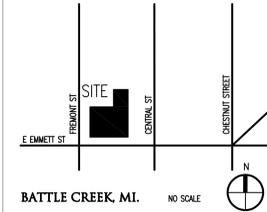

**BUILDING:** .....  
 BUILDING AREA(S) = 000,000 SQ. FT. (ADDITION)  
 34,096 SQ. FT. (EXISTING)  
 34,096 SQ. FT. (TOTAL)  
 1,043 SQ. FT. (EXISTING ROOF ALTERED)

**CODE:** .....  
**GOVERNING CODES:**  
 - 2016 SCHOOL FIRE SAFETY RULES  
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**CONSTRUCTION CLASSIFICATION:** TYPE II (000)  
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**USE GROUP CLASSIFICATION:** "E" EDUCATION

**ADDRESS:** BATTLE CREEK PUBLIC SCHOOLS  
 115 E EMMETT STREET  
 BATTLE CREEK, MI 49017

.....  
 .....  
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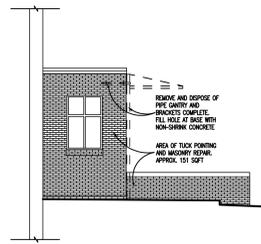
**PROJECT TITLE**  
**Fremond Academy Roofing Reno.**  
**PROJECT NO.**  
**25041J**  
**DRAWING NO.**  
**TS.1**

**LICENSEE'S STATEMENT:**


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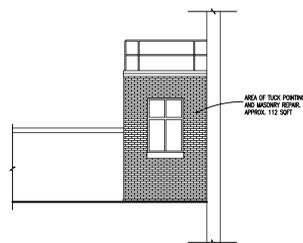





4 WEST ELEVATION  
SCALE: 1/8" = 1'-0"




3 SOUTH ELEVATION  
SCALE: 1/8" = 1'-0"

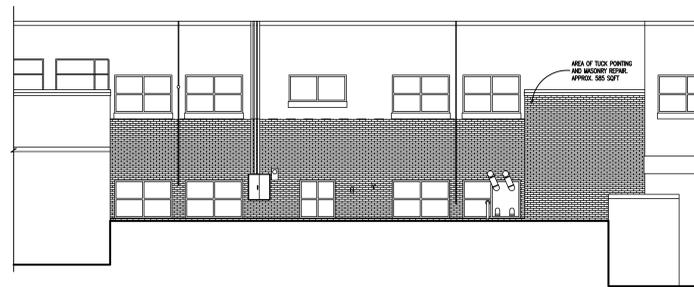


2 EAST ELEVATION  
SCALE: 1/8" = 1'-0"

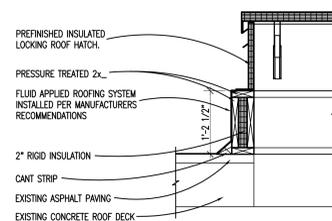

1 ROOF HATCH SECTION  
SCALE: 3/4" = 1'-0"

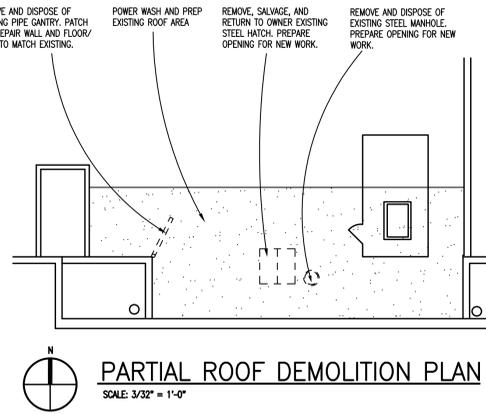

PARTIAL ROOF DEMOLITION PLAN  
SCALE: 3/32" = 1'-0"

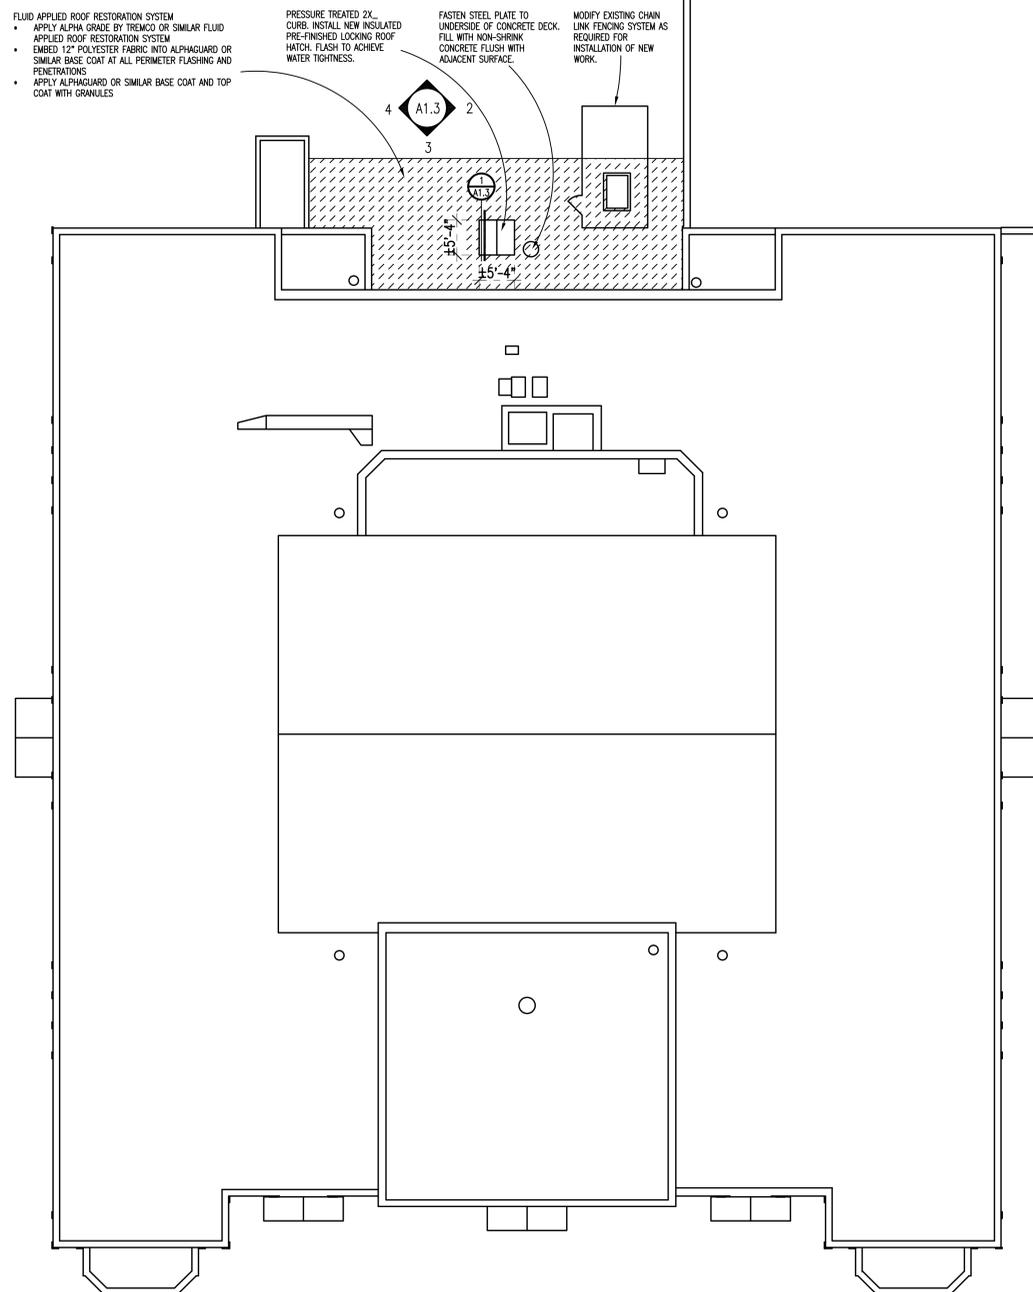

COMPOSITE ROOF PLAN  
SCALE: 3/32" = 1'-0"

ROOF PLAN LEGEND	
+	EXISTING ROOF DRAIN
⊕	EXISTING VENT STACK, EXHAUST, MECHANICAL PENETRATION. SEE GENERAL ROOF NOTE 3.

GENERAL NOTES	
1.	INFORMATION FOR EXISTING CONDITIONS TAKEN FROM OWNER PROVIDED DOCUMENTS AND VISUAL INSPECTIONS OF THE BUILDING. CONTRACTOR SHALL VERIFY ALL EXISTING CONDITIONS IN THE FIELD PRIOR TO INSTALLATION OF NEW WORK AND REPORT ALL DISCREPANCIES TO THE ARCHITECT AND CONSTRUCTION MANAGER.
2.	CONTRACTOR SHALL BE RESPONSIBLE FOR THE PROTECTION OF ALL EXISTING UTILITIES ON OR NEAR THE PROJECT ROOF DURING THE WORK. PROVIDE PROPER SAFETY MEASURES NEAR ELECTRICAL SERVICE LINES.
3.	ROOF PENETRATIONS AND THEIR LOCATIONS ARE APPROXIMATE. CONTRACTOR SHALL BE RESPONSIBLE FOR PROPER FLASHING OF ALL EXISTING DRAINS, CURBS, VENT STACKS, ETC., AFFECTED WITHIN THE PROJECT SCOPE.
4.	CONTRACTOR SHALL DISCONNECT AND RECONNECT EQUIPMENT AS REQUIRED TO COMPLETE ROOF REPAIRS. EMPLOY MECHANICAL OR ELECTRICAL SUBCONTRACTORS AS NEEDED. COORDINATE THIS WORK WITH THE CONSTRUCTION MANAGER AND OWNER.
5.	EXISTING LIGHTS, LADDERS, ANTENNA, GUTTERS, DOWNSPOUTS, MECHANICAL UNITS, VENT STACKS & OTHER ROOF TOP EQUIPMENT & PENETRATIONS ARE TO REMAIN UNLESS SPECIFICALLY CALLED OUT OTHERWISE.



TMP ARCHITECTURE INC  
259 E. MICHIGAN AVENUE, SUITE 308  
KALAMAZOO - MICHIGAN - 49007  
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REGISTRATION SEAL

CONSULTANT

PROJECT TITLE  
**Fremont Academy  
Roofing  
Renovations**

**Battle Creek Public Schools  
Battle Creek, Michigan**

DRAWING TITLE  
**Composite Roof Plans  
and Details**

ISSUE DATES

01-12-2026 CONSTRUCTION DOCUMENTS

DATE ISSUED FOR:

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CHECKED EW


APPROVED FG

PROJECT NO.

**25041J**

DRAWING NO.

**A1.3**

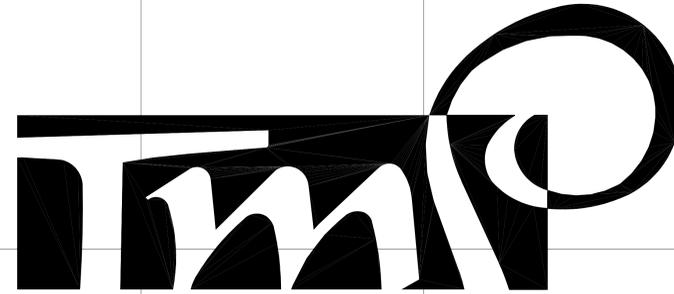

A R C H I T E C T U R E

T M P A R C H I T E C T U R E I N C  
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# URBANDALE ELEMENTARY ROOFING RENOVATIONS

## BATTLE CREEK PULBIC SCHOOLS

BATTLE CREEK, MI 49017  
 PROJECT NUMBER 25041T  
 CONSTRUCTION DOCUMENTS

**CONSULTANTS:**

**ELECTRICAL ENGINEER**  
**IGNYTE DESIGN**  
**ELECTRICAL ENGINEERS**  
 123 DEVISSER PLACE  
 KALAMAZOO, MI 49007  
 PHONE: (269) 207-9247

**LIST OF DRAWINGS**

**GENERAL INFORMATION** .....  
 TS.1 COVER SHEET  
 TG.1 GENERAL INFORMATION

**ARCHITECTURAL** .....

A1.3 COMPOSITE ROOF PLAN

**PROJECT DATA:**

**LOCATION MAP**



BATTLE CREEK, MI. NO SCALE

**BUILDING:** .....

BUILDING AREA(S) = 000,000 SQ. FT. (ADDITION)  
 37,455 SQ. FT. (EXISTING)  
 37,455 SQ. FT. (TOTAL)  
 37,455 SQ. FT.  
 (EXISTING PARAPET REPLACED)

**CODE:** .....

- GOVERNING CODES:**
- 2016 SCHOOL FIRE SAFETY RULES (2012 Life Safety Code, plus amendments)
  - 2021 MICHIGAN BUILDING CODE
  - 2021 MICHIGAN REHABILITATION CODE FOR EXISTING BUILDINGS
  - 2021 MICHIGAN PLUMBING CODE
  - 2021 MICHIGAN MECHANICAL CODE
  - 2021 MICHIGAN COMMERCIAL ENERGY CODE (ANSI/ASHRAE/IES Standard 90.1-2019)
  - 2023 MICHIGAN ELECTRICAL CODE (2023 NEC, plus Part 8 Rules)
  - 2023 MICHIGAN ELEVATOR RULES (ASME A17.1-2016, ASME A18.1-2017)
  - MICHIGAN BARRIER FREE CODE (Michigan Building Code 2021 and ICC A117.1-2017)
  - 2019 MICHIGAN BOILER CODE RULES (ASME Boiler and Pressure Vessel Code, 2019 edition) (National Board Inspection Code [NBIC], 2019 edition)
- CONSTRUCTION CLASSIFICATION : TYPE II (000)  
 LSC TYPE II-B (MBC)  
 USE GROUP CLASSIFICATION : "E" EDUCATION

**ADDRESS:** BATTLE CREEK PUBLIC SCHOOLS  
 123 BEDFORD ROAD N  
 BATTLE CREEK, MI ZIP 49037

**REGISTRATION SEALS**

**LICENSEE'S STATEMENT:**

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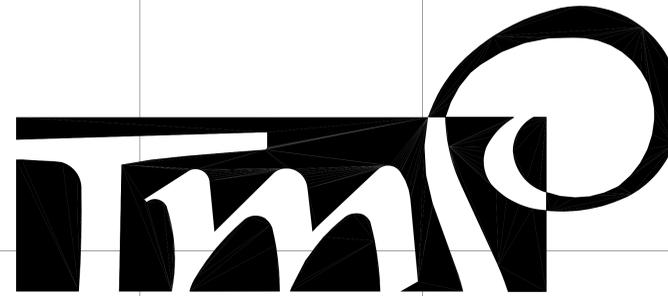
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**PROJECT TITLE**  
**Urbandale Elem. Roofing Reno.**  
**PROJECT NO.**  
**25041T**  
**DRAWING NO.**  
**TS.1**

01-12-2026 CONSTRUCTION DOCUMENTS  
**DATE ISSUED FOR:**







ARCHITECTURE

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# W. K. Kellogg Roofing Renovations BATTLE CREEK PULBIC SCHOOLS

## BATTLE CREEK, MI 49017 PROJECT NUMBER 25041W CONSTRUCTION DOCUMENTS


### LIST OF DRAWINGS

GENERAL INFORMATION .....  
TS.1 COVER SHEET  
TG.1 GENERAL INFORMATION

ARCHITECTURAL .....  
A1.3 COMPOSITE ROOF PLAN  
A4.1 WALL SECTIONS

### PROJECT DATA:

#### LOCATION MAP

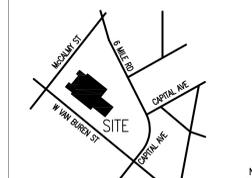

BATTLE CREEK, MI. NO SCALE

**BUILDING:** .....  
BUILDING AREA(S) = 000,000 SQ. FT. (ADDITION)  
146,342 SQ. FT. (EXISTING)  
146,342 SQ. FT. (TOTAL)  
54,411 SQ. FT. (ROOFING REPLACEMENT)

**CODE:** .....  
**GOVERNING CODES:**  
- 2016 SCHOOL FIRE SAFETY RULES  
(2012 Life Safety Code, plus amendments)  
- 2021 MICHIGAN BUILDING CODE  
- 2021 MICHIGAN REHABILITATION CODE FOR EXISTING BUILDINGS  
- 2021 MICHIGAN PLUMBING CODE  
- 2021 MICHIGAN MECHANICAL CODE  
- 2021 MICHIGAN COMMERCIAL ENERGY CODE  
(ANSI/ASHRAE/IES Standard 90.1-2019)  
- 2023 MICHIGAN ELECTRICAL CODE (2023 NEC, plus Part 8 Rules)  
- 2023 MICHIGAN ELEVATOR RULES  
(ASME A17.1-2016, ASME A18.1-2017)  
- MICHIGAN BARRIER FREE CODE  
(Michigan Building Code 2021 and ICC A117.1-2017)  
- 2019 MICHIGAN BOILER CODE RULES  
(ASME Boiler and Pressure Vessel Code, 2019 edition)  
(National Board Inspection Code [NBIC], 2019 edition)  
**CONSTRUCTION CLASSIFICATION:** TYPE II (000)  
LSC TYPE II-B (MBC)  
**USE GROUP CLASSIFICATION:** "E" EDUCATION

**ADDRESS:** BATTLE CREEK PUBLIC SCHOOLS  
60 W. VAN BUREN STREET  
BATTLE CREEK, MICHIGAN 49017

### REGISTRATION SEALS

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**PROJECT TITLE**  
**W. K. Kellogg Roofing Reno.**  
**PROJECT NO.**  
**25041W**  
**DRAWING NO.**  
**TS.1**

DATE ISSUED FOR:  
01-12-2026 CONSTRUCTION DOCUMENTS





